
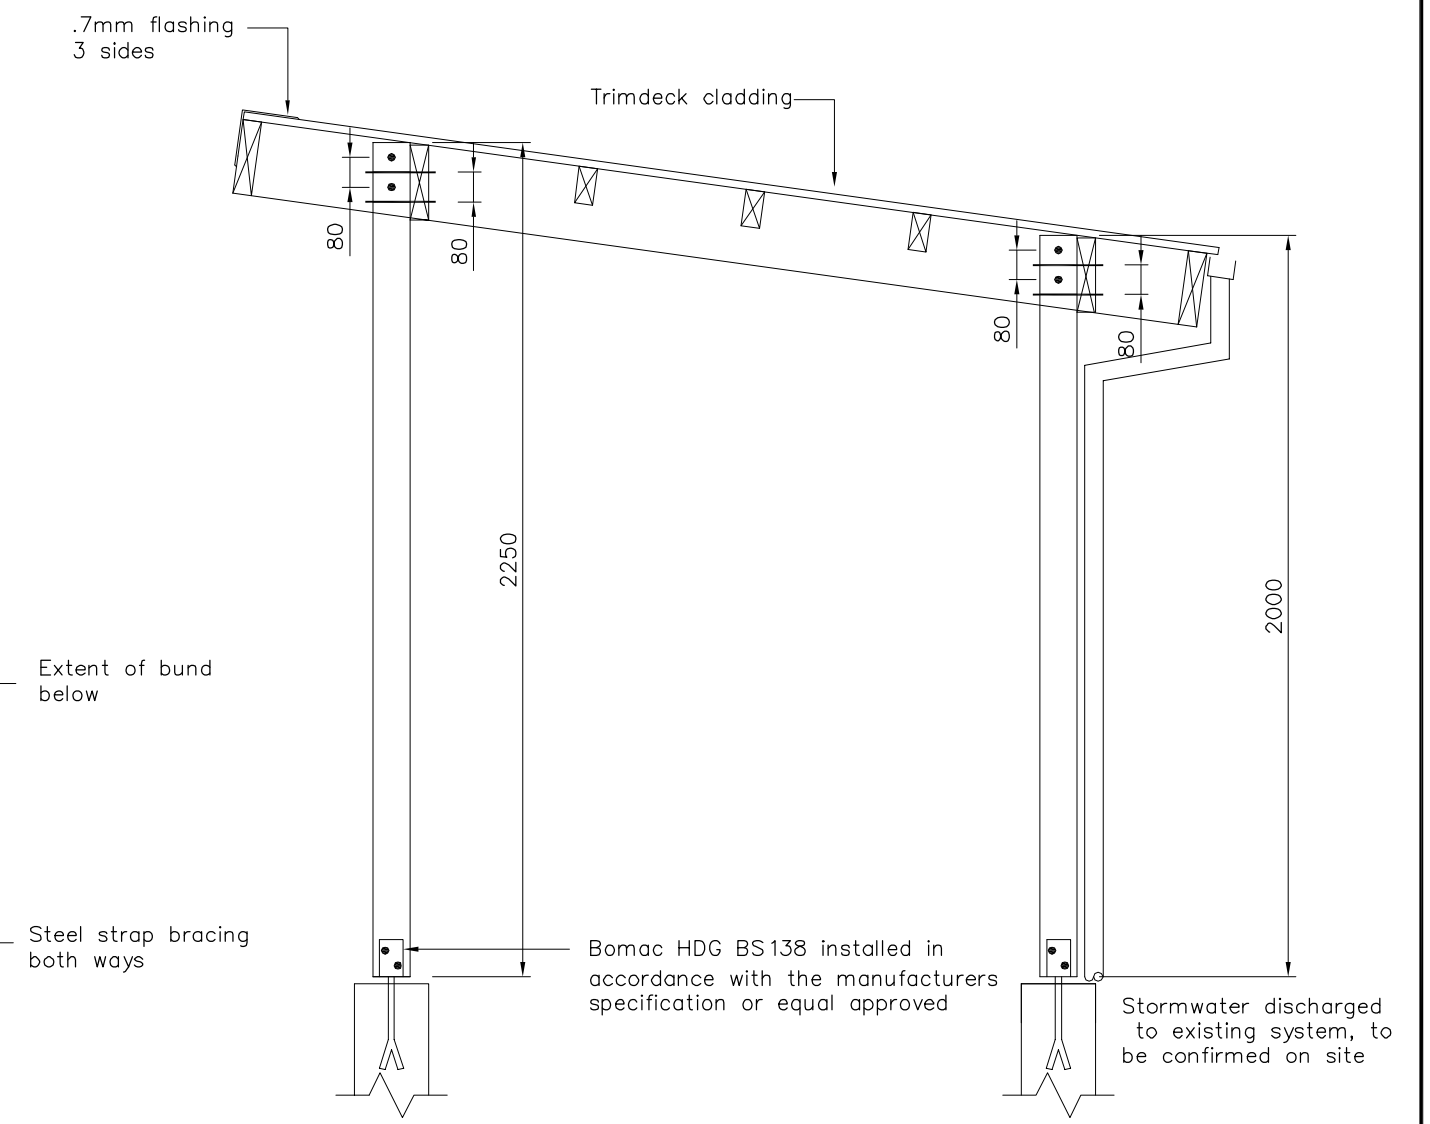


ROOF FRAMING PLAN  
SCALE 1 : 20

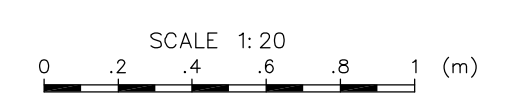

SECTION 1-1  
SCALE 1 : 20

DESIGNED :	TGM	Jun.02
DRAWN :	TGM	Jun.02
DESIGN CHECKED :		
DRAFTING CHECKED :		
CADFILE : L:\50500-02		
APPROVED :		
This drawing is not to be used for construction purposes unless signed as approved		
0 First Issue		
REVISION DESCRIPTION	BY	DATE

NOTES :

- All dimensions are in millimetres unless noted otherwise.
- All timber to be treated to H3 to NZ timber Preservation Council standards
- All construction to comply with NZS 3604:Timber Framed Buildings and the New Zealand Building Code
- All M12 bolts to have 50mm dis x 3mm washers
- All fixings to be hot dipped galvanized

REFERENCE :

**Tonkin & Taylor**  
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CLIENT, PROJECT	<b>ENVIRONMENT CANTERBURY</b>
	HAZARDOUS WASTE STORAGE FACILITIES
TITLE	GENERIC DESIGN FOR USED OIL STORAGE FACILITY
	ROOF STRUCTURE
SCALES (AT A3 SIZE)	1: 20
DWG. No.	50500-002
REV.	0